## AMENDMENT NO. 1 TO LEASE AGREEMENT BETWEEN

# ITEM # 18-0387

### THE CITY OF SANTA FE AND T-MOBILE WEST LLC

WHEREAS, the Parties entered into a LEASE AGREEMENT BETWEEN THE CITY OF SANTA FE AND T-MOBILE WEST LLC dated June 15, 2017 (City Item #17-0533) (the "Lease Agreement") regarding the lease of a two hundred fifty-six and six tenths (256.6) square-foot parcel of land, ten (10) vertical feet of air space above the existing surface of the parcel of land, and designated space on an adjacent monopole-style tower (the "City Tower") (collectively, the "Premises"), located within a certain Lessor-owned parcel of land known as 801 W. San Mateo Road located within the municipal boundaries of the City of Santa Fe, in the County of Santa Fe, State of New Mexico (the "Property"), whereon Lessor owns and maintains the City Tower for municipal telecommunications purposes; and

WHEREAS, Lessee desires to lease additional designated space on the City Tower to accommodate a greater number and size of Communication Facilities as defined in the Lease Agreement; and

WHEREAS, Lessor desires to lease additional space on the City Tower to Lessee.

**NOW THEREFORE**, the Parties agree to amend the Lease Agreement as follows:

- 1) Exhibit A of the Agreement is amended to include "Exhibit A (Supplement)" attached hereto and incorporated herein as part of this Amendment No.1.
- 2) Section 6.A. <u>Rent</u> is deleted and replaced with the following to reflect a new Rent amount which shall commence on May 1, 2018:
- "A. Rent. Lessee shall pay Lessor a monthly rental fee of Three Thousand Six Hundred Dollars (\$3,600) on or before the first day of each month (Rent). Rent shall commence on the Effective Date and shall be paid into Lessor's bank account via electronic funds transfer as directed by Lessor from time to time."
- 3) Lessee shall construct any and all structural modifications to the City Tower necessary to accommodate the increased number and size of its Communication Facilities. Required structural modifications shall be designed by a licensed structural engineer and constructed at Lessee's sole expense. Lessee shall commence construction of any such structural modifications and installation of any Communications Facilities in accordance with Section 3.B of the Lease Agreement.
- 4) Except as provided in this Amendment No.1, all provisions of the Lease Agreement shall remain unchanged and in full force and effect. To the extent there is any conflict between the terms and conditions of the Lease Agreement and this Amendment No.1, the terms and conditions of this Amendment No.1 will govern and control.

- 5) Approvals. Lessor represents and warrants to Lessee that the consent or approval of no third party, including, without limitation, a lender, is required with respect to the execution of this Amendment No.1, or if any such third party consent or approval is required, Lessor has obtained any and all such consents or approvals.
- 6) <u>Authorization</u>. The persons who have executed this Amendment No.1 represent and warrant that they are duly authorized to execute this Amendment No.1 in their individual or representative capacity as indicated.

[REMAINDER OF THIS PAGE LEFT BLANK INTENTIONALLY.]
[SIGNATURES APPEAR ON THE FOLLOWING PAGE.]

| <b>IN WITNESS WHEREOF</b> , the Parties has of the date entered above.   | ve caused this Amendment No.1 to be effective as                               |
|--|--|
|  | LESSOR:<br>CITY OF SANTA FE  |
|  | 311-   |
| ATTEST:  | BRIANK. SNYDER, CITY MANAGER   |
| Molanda Y. VIGILICITY CLERK mb   |  |
| APPROVED AS TO FORM:   |  |
| KELLEY A. BRENNAT, CITY ATTORNEY   |  |
| APPROYED:  3/21/18  ADAM K. JOHNSON, FINANCE DIRECTOR  |  |
| BUS.UNIT/LINE ITEM: <u>51300.460350</u>  |  |
| robert.doan Digitally signed by robert.doane@t-mobile.com  e@t- DN: cn=robert.doane@t-mobile.com Date: 2018.03.20 10:18:27 -07'00' | LESSEE: T-MOBILE WEST LLC, A DELAWARE LIMITED LIABILITY COMPANY  Todd VanCleve |
| T-Mobile Legal Approval  | Area Director, Network Engineering and C<br>Mountain West Area                 |
|  | Printed Name:  Title:  |
| ΔCKNOWI  | 4/10/1 <b>8</b><br>Ledgement   |
| STATE OF ACCOPA ) ss. COUNTY OF MACCOPA )  | 1011-  |
| The foregoing instrument was acknowl 2018, by Todd Volor of T Mobile West LLC, a Delaware Limited Li                               | ncleve as Area Director  |

My Commission Expires: May 16, 2021

[SEAL]

JENNIFER ASHLEY LECLAIR Notary Public, State of Arizona Maricopa County My Commission Expires May 16, 2021

# **EXHIBIT A (SUPPLEMENT)**

[SEE ATTACHED 4 SHEETS]

# -T- - - Mobile -

T-Mobile West LLC, a Limited Liability Company


# L600 UPGRADE ON EXISTING 67' MONOPOLE TOWER

T-MOBILE SITE ID NM01247B T-MOBILE SITE NAME CITY OF SANTA FE WATER UTILITY

SITE ADDRESS

801 WEST SAN MATEO ROAD SANTA FE, NEW MEXICO 87505 SANTA FE COUNTY

> LATITUDE: 35.661858° LONGITUDE: -105.961743°

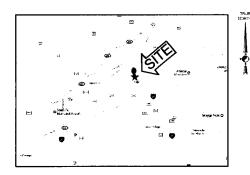



SITE LOCATION MAP

**AERIAL DETAIL MAP** 

| SHEET INDEX |                 |  |  |  |  |  |
|-------------|-----------------|--|--|--|--|--|
| SHEET       | TITLE           |  |  |  |  |  |
| 1 OF 4      | TITLE PAGE      |  |  |  |  |  |
| 2 OF 4      | SITE PLAN       |  |  |  |  |  |
| 3 OF 4      | SITE ELEVATION  |  |  |  |  |  |
| 4 OF 4      | ANTENNA DETAILS |  |  |  |  |  |

#### PROJECT CONTACTS

TOWER OWNER: CITY OF SANTA FE
CONTACT: MATT O'REILLY ( DIRECTOR OF REALESTATE) PH. (505) 955-6213 EMAIL: MSOREILLY@SANTAFENM.GOV

APPLICANT: T-MOBILE WEST, LLC A LIMITED LIABILITY COMPANY 4830 PAN AMERICAN FREEWAY N.E., STE A ALBUQUERQUE, NEW MEXICO 87109

A&E FIRM: CLEAR WATER COMMUNICATIONS, INC. 5327 TIMBER TRAIL SAN ANTONIO, TEXAS 78228 CONTACT: MIKKO P. AHOLA, P.E. PHONE: (210) 684-3877

LEASING/ZONING: ROMANO AND ASSOCIATES, LLC 8100 WYOMING BLVD NF #M4-167 ALBUQUERQUE, NM 87113 CONTACT: NICK ROMANO PHONE: (505) 750-0735

#### SCOPE OF WORK:

REMOVE: EXISTING ANTENNAS & ANTENNA MOUNTS @ 45°C" TOWER LEVEL

INSTALE
(3) RFS APXVAA24\_4S-U-A20 QUAD ANTENNAS (1 PER SECTOR, POSITION 2)
(3) ERICSSON 4478 B71 RADIO'S (1 PER SECTOR, POSITION 2)
(3) ERICSSON RRUS11 B2 RADIOS (1 PER SECTOR, POSITION 1) (1) VALMONT SITE PROTITIPLE T-ARM MOUNT (5-0" FACE), P/N: UDS-NP (6) 2-3/8" X 8'-0" ANTENNA MOUNT PIPES

(1) 6X12 HCS RELOCATE EXISTING (3) ERICSSON AIR32 82A/866AA ANTENNAS TO NEW ANTENNA MOUNTS

REFER TO TOWER STRUCTURAL MODIFICATION DRAWINGS DATED 11/08/2017) FOR REQUIRED TOWER REINFORCEMENT PRIOR TO PROPOSED T-MOBILE EQUIPMENT UPGRADE.

#### APPLICABLE CODES

' ALL WORK SHALL BE PERFORMED AND MATERIALS INSTALLED IN ACCORDANCE WITH THE FOLLOWING CODES INSTALLED IN ACCORDANCE WITH THE FOLLOWING CODES AS ADOPTED BY THE LOCAL GOVERNING AUTHORITIES. NOTHING IN THESE PLANS IS TO BE CONSTRUED TO PERMIT WORK NOT CONFORMING TO THESE CODES.

2015 INTERNATIONAL BUILDING CODE 2015 NEW MEXICO COMMERCIAL BUILDING CODE 2014 NATIONAL ELECTRIC CODE

## ·T···Mobile

830 PAN AMERICAN FRWY., NE SUITE

ALBUQUERQUE, NM 87109

CLEAR WATER COMMUNICATIONS, INC. 5327 TIMBER TRAIL

SAN ANTONIO, TEXAS 78228 clearwaterengineeringinc@yahoo.com FIR VI REGISTRATION NUMBER F-4080

| ISSUED FOR:                 | DATE     |
|-----------------------------|----------|
| L600 EXHIBIT                | 08-10-17 |
| ISSUL SEI                   | 08-29-17 |
| REV 1 - ADD CITY 2' MW DISH | 11-08-17 |
|                             |          |
|                             |          |
|                             |          |
|                             |          |
|                             |          |
|                             |          |
| 1                           |          |




SITE ID: NM01247B SITE NAME: CITY OF SANTA FE WATER UTILITY SITE ADDRESS: 801 W SAN MATEO ROAD SANTA FE, NM 87505


SHEET TITLE

TITLE PAGE

SHEET NUMBER

1 OF 4

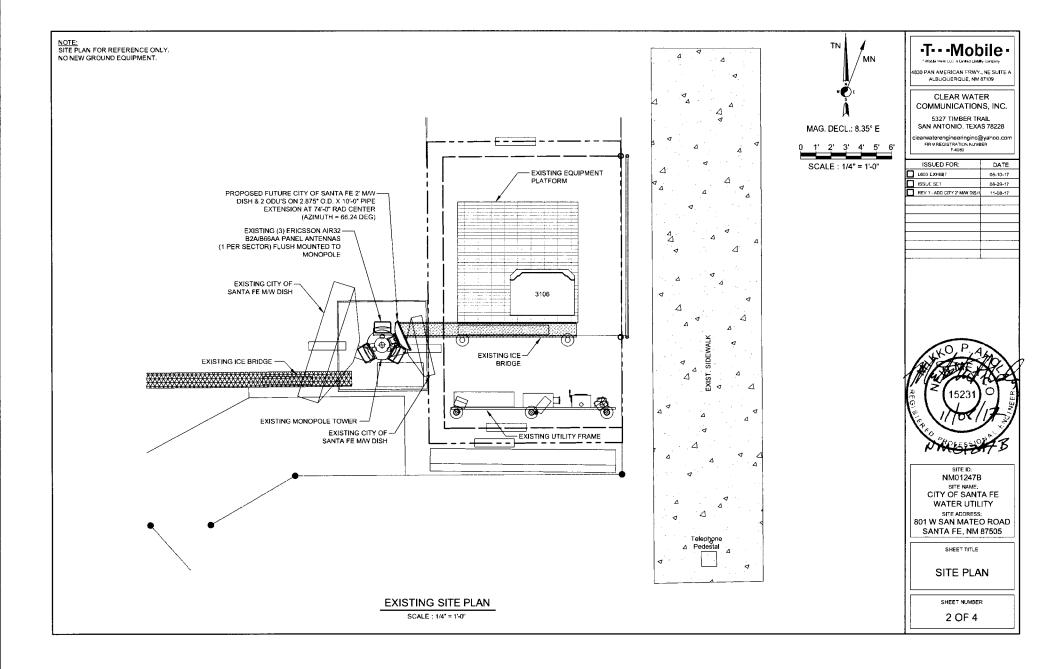

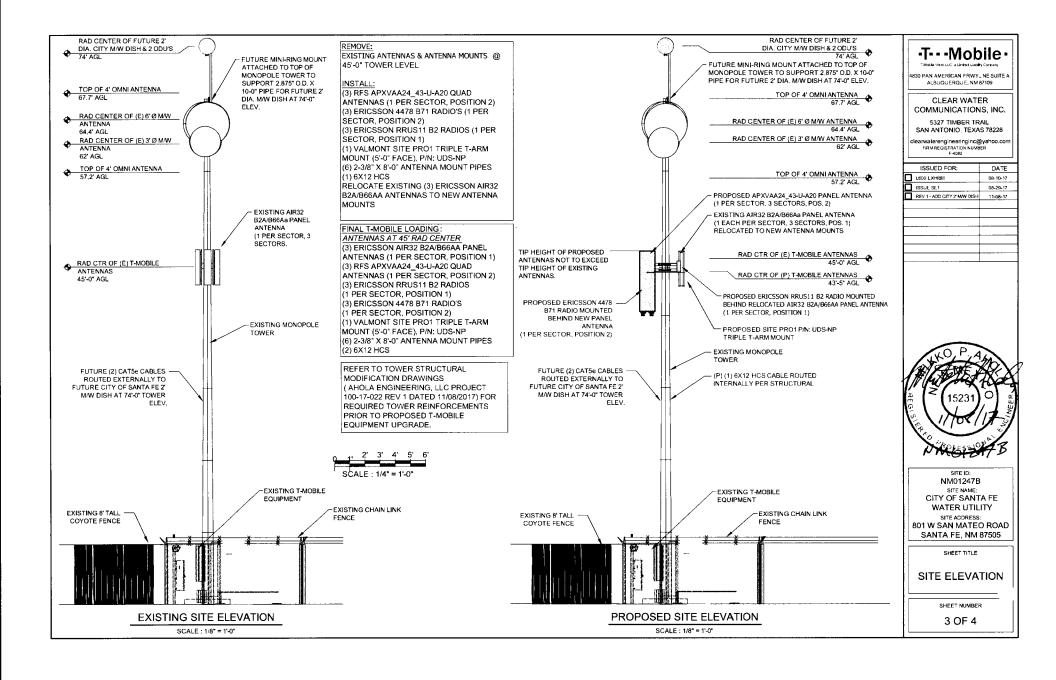

ALL EQUIPMENT TO BE INSTALLED AS PER LATEST T-MOBILE RFDS





SIDE VIEW FRONT VIEW

NOTE; ALL AZIMUTHS ARE FROM TRUE NORTH.

DIMENSIONS: 96" TALL, 24.6" WIDE, 8.5" DEEP WEIGHT = 101.4 LB (ANTENNA ONLY)
WEIGHT = 124.4 LB (ANTENNA + MOUNTING HARDWARE)
RADOME/COLOR = FIBERGLASS/LIGHT GREY ANTENNA VIEWS ARE APPROXIMATE


RFS APXVAA24\_43-U-A20 QUAD

SCALE: NONE




ERICSSON RRUS11 B2 HxWxD=19,7"x17"x7,2" (WEIGHT=50 LBS) RRUS11 B2

SCALE : N.T.S.

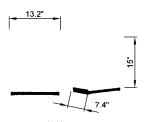

ERICSSON 4478 B71 HxWxD=15"x13.2"x7.4" (WEIGHT=60 LBS) ERICSSON 4478 B71 RADIO

SCALE: NONE

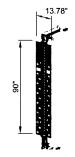


MPF SPECIFICATIONS: -PRODUCT NUMBER: SXK 10-1921/(1-3) -STEEL THICKNESS: .118" -WIDTH: 13.78" CLAMP MOUNTING RANGE; -TUBES Ø 3.0"-5.47" -SQUARE PROFILES 2.36"- 4.72" -90° ANGLE 2.36"- 4.72"

#### MULTI PURPOSE MOUNTING FRAME


MONOPOLE

TOWER

SCALE: NONE

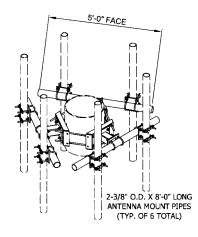



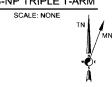

MAG, DECL.: 8.34° E 0 1' 2' 3' 4' 5' 6' SCALE : 1/4" = 1'-0" PROPOSED TRIPLE T-ARM MOUNT

PROPOSED RRUS11 B2 RADIO UNITS (1 PER SECTOR, 3 SECTORS, POS. 1)

EXISTING AIR32 B2A/B66Aa PANEL ANTENNA (1 PER SECTOR, 3 SECTORS, POS. 1)

PROPOSED APXVAA24\_43-U-A20 PANEL ANTENNA (1 PER SECTOR, 3 SECTORS.

PROPOSED 4478 B71 RADIO UNIT BEHIND PANEL ANTENNA (1 PER SECTOR, 3 SECTORS, POS. 2)

POS. 2)

PROPOSED ANTENNA PLAN @ 45' RAD

SCALE : 1/4" = 1'-0"

SITE ID: NM01247B

-T---Mobile

4830 PAN AMERICAN FRWY., NE SUITE A ALBUQUERQUE, NM 87109

CLEAR WATER

COMMUNICATIONS, INC.

5327 TIMBER TRAIL SAN ANTONIO, TEXAS 78228 clearwaterengineeringinc@yahoo.com FIR VIREGISTRATION NUVIBER F-4080

DATE

08-10-17

08-29-17

11-08-17

ISSUED FOR:

REV 1 - ADD CITY 2' MW DISH

L600 EXHIBIT

ISSUE SET

SITE NAME: CITY OF SANTA FE WATER UTILITY SITE ADDRESS: 801 W SAN MATEO ROAD **SANTA FE, NM 87505** 

SHEET TITLE

**ANTENNA DETAILS** 

SHEET NUMBER

4 OF 4

| FINAL T-MOBILE ANTENNA SCHEDULE |          |                          |                         |                         |         |            |                              |                                |                    |                          |          |
|---------------------------------|----------|--------------------------|-------------------------|-------------------------|---------|------------|------------------------------|--------------------------------|--------------------|--------------------------|----------|
| SECTOR                          | QUANTITY | ANTENNA                  | MECHANICAL<br>DOWN TILT | ELECTRICAL<br>DOWN-TILT | AZIMUTH | No. CABLES | CABLE TYPE                   | ESTIMATED COAX<br>CABLE LENGTH | MOUNTING<br>HEIGHT | HORIZONTAL<br>SEPARATION | STATUS   |
| 1                               | 1        | ERICSSON AIR32 B2A/B66AA | N/A                     | N/A                     | 0°      | 1 1        | 6X12 HCS (E)<br>6x12 HCS (P) | N/A                            | 45'                | N/A                      | EXISTING |
|                                 | 1        | RFS APXVAA24_43-U-A20    | N/A                     | N/A                     | 0°      |            |                              | N/A                            | 43'-5"             | N/A                      | PROPOSED |
|                                 | 1        | ERICSSON 4478 B71        | N/A                     | N/A                     | N/A     |            |                              | N/A                            | 43'-5"             | N/A                      | PROPOSED |
|                                 | 1        | ERICSSON RRUS 11 B2      | N/A                     | N/A                     | N/A     |            |                              | N/A                            | 45'                | N/A                      | PROPOSED |
| 2                               | 1        | ERICSSON AIR32 B2A/B66AA | N/A                     | N/A                     | 120°    |            |                              | N/A                            | 45'                | N/A                      | EXISTING |
|                                 | 1        | RFS APXVAA24_43-U-A20    | N/A                     | N/A                     | 120°    |            |                              | N/A                            | 43'-5'             | N/A                      | PROPOSED |
|                                 | 1        | ERICSSON 4478 B71        | N/A                     | N/A                     | N/A     |            |                              | N/A                            | 43'-5"             | N/A                      | PROPOSED |
|                                 | 1        | ERICSSON RRUS11 B2       | N/A                     | N/A                     | N/A     |            |                              | N/A                            | 45'                | N/A                      | PROPOSED |
| 3                               | 1        | ERICSSON AIR32 B2A/B66AA | N/A                     | N/A                     | 240°    |            |                              | N/A                            | 45'                | N/A                      | EXISTING |
|                                 | 1        | RFS APXVAA24_43-U-A20    | N/A                     | N/A                     | 240°    |            |                              | N/A                            | 43'-5"             | N/A                      | PROPOSED |
|                                 | 1        | ERICSSON 4478 B71        | N/A                     | N/A                     | N/A     |            |                              | N/A                            | 43'-5"             | N/A                      | PROPOSED |
|                                 | 1        | ERICSSON RRUS11 B2       | N/A                     | N/A                     | N/A     |            |                              | N/A                            | 45'                | N/A                      | PROPOSED |